SECTION 16, TOWNSHIP 33 NORTH, RANGE 04 EAST, W.M.

BASIC SOIL AMENDMENT NOTES

- 1. A TOPSOIL LAYER WITH A MINIMUM ORGANIC MATTER CONTENT OF 10% DRY WEIGHT IN PLANTING BEDS, AND 5% ORGANIC MATTER CONTENT (BASED ON A LOSS-ON-IGNITION TEST) IN TURF AREAS, AND A PH FROM 6.0 TO 8.0 OR MATCHING THE PH OF THE ORIGINAL UNDISTURBED SOIL. THE TOPSOIL LAYER SHALL HAVE A MINIMUM DEPTH OF 8" EXCEPT WHERE TREE ROOTS LIMIT THE DEPTH OF INCORPORATION OF AMENDMENTS NEEDED TO MEET THE CRITERIA. SUBSOILS BELOW THE TOP SOIL LAYER SHOULD BE SCARIFIED AT LEAST FOUR INCHES WITH SOME INCORPORATION OF THE UPPER MATERIAL TO AVOID STRATIFIED LAYERS, WHERE FEASIBLE.
- 2. PLANTING BEDS MUST BE MULCHED WITH TWO INCHES OF ORGANIC MATERIAL.
- 3. QUALITY OF COMPOST AND OTHER MATERIALS USED TO MEET THE ORGANIC CONTENT **REQUIREMENTS:**
- 3.a. THE ORGANIC CONTENT FOR QUOTE PRE-APPROVED END QUOTE AMENDMENT RATES CAN BE MET ONLY BY USING COMPOST MEETING AND SPECIFICATION FOR BMP T7.30: BIO-RETENTION, WITH THE EXCEPTION THAT THE COMPOST MAY HAVE UP TO 35% BIO-SOLIDS OR MANURE. THE COMPOST MUST ALSO HAVE AN ORGANIC MATTER CONTENT OF 40% TO 65%, AND A CARBON TO NITROGEN RATIO BELOW 25:1. THE CARBON TO NITROGEN RATIO MAY BE AS HIGH AS 35:1 FOR PLANTINGS COMPOSED ENTIRELY OF PLANTS NATIVE TO THE PUGET SOUND LOWLANDS REGION.
- 3.b. CALCULATED AMENDMENT RATES MAY BE MET THROUGH USE OF COMPOSTED MATERIALS AS DEFINED ABOVE; OR OTHER ORGANIC MATERIALS AMENDED TO MEET THE CARBON TO NITROGEN RATIO REQUIREMENTS, AND NOT EXCEEDING THE CONTAMINANT LIMIT IDENTIFIED IN TABLE 220-B, TESTING PARAMETERS, IN WAC 173 - 350 - 220.
- 4. AMEND DISTURBED SOIL ACCORDING TO THE FOLLOWING PROCEDURES:
- 4.a. SCARIFY SUBSOIL TO A DEPTH OF 1 FOOT.
- IN PLANTING BEDS, PLACE THREE INCHES OF COMPOST UNTIL IN AN 8 INCH DEPTH. 4.b.
- IN TURF AREAS, PLACE TWO INCHES OF COMPOST UNTIL IN AN 8 INCH DEPTH. 4.c.
- 4.d. APPLY TWO TO FOUR INCHES OF ARBORIST WOOD CHIPS, COARSE BARK MULCH, OR COMPOST MULCH TO PLANTING BEDS AFTER FINAL PLANTING. ALTERNATIVELY, DISTURBED SOIL CAN BE AMENDED ON A SITE CUSTOMIZED MANNER SO THAT IT MEETS THE SOIL QUALITY CRITERIA SET FORTH ABOVE, AS DETERMINED BY A LICENSED ENGINEER, GEOLOGIST, LANDSCAPE ARCHITECT, OR OTHER PERSON AS APPROVED BY SKAGIT COUNTY.
- 5. STOCKPILE EXISTING TOPSOIL DURING GRADING AND REPLACED IT PRIOR TO THE PLANTING. STOCKPILE TOPSOIL MUST BE AMENDED IF NEEDED TO MEET THE ORGANIC MATTER AND DEPTH REOUIREMENTS BY FOLLOWING THE PROCEDURES IN METHOD (4) ABOVE.
- IMPORT TOPSOIL MIX OF SUFFICIENT ORGANIC CONTENT AND DEPTH TO MEET THE 6. ORGANIC MATTER AND DEPTH REQUIREMENTS. MORE THAN ONE METHOD MAY BE USED ON DIFFERENT PORTIONS OF THE SAME SITE. SOILS THAT ALREADY MEET THE DEPTH AND ORGANIC MATTER OUALITY STANDARDS, AND IS NOT COMPACTED, DOES NOT NEED TO BE AMENDED.


SURVEY NOTE

A TOPOGRAPHIC SURVEY, WITHIN AREA OF DISTURBANCE, HAS BEEN PERFORMED BY NORTHLINE SURVEYING.

DRAINFIELD/RESERVE NOTE

Know what's below. Call before you dig. EXTREME CAUTION TO BE TAKEN IN AREA OF DRAINFIELD AND RESERVE. CONTRACTOR TO AVOID ADDITIONAL GRADING OR COMPACTING IN AREA OF DRAINFIELD/RESERVE.

P:\WORK\PROJECTS\2021\21-414 LAKE 16\CE\SHEETS\LOT 11 SITE PLAN-REVISION.DWG 6/23/2023

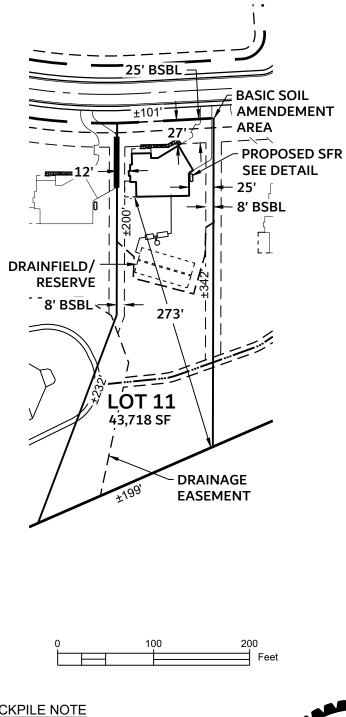

OWNER/APPLICANT

LAKE 16 LLC PLATS PLUS INC 2440 W COMMODORE WAY #200 SEATTLE, WA 98199

ARCHITECT

NASH & ASSOCIATES 8003 118TH AVENUE NE **KIRKLAND, WA 98033** PH: 425-828-4117


SITE INFORMATION


SITE ADDRESS

TAX ACCOUNT NO: ZONING:

LEGAL DESCRIPTION

RECORDED UNDER AF#201904190032

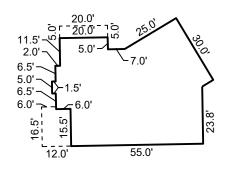

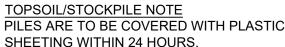

CONTRACTOR TO INSTALL SILT FENCING WHERE NECESSARY ALONG PERIMETER IF VEGETATIVE BUFFER DOES NOT PROVIE ADEQUATE PROTECTION.

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SFR DIMENSIONS

SCALE: 1" = 40'

CIVIL ENGINEER

DAVID HARMSEN, PE HARMSEN LLC 125 E MAIN ST SE, STE 104 **MONROE, WA 98272** PH: 360-794-7811

EMAIL: davidh@harmsenllc.com



20608 SINNES RD. **MT. VERNON. WA 98274**


P134696 RURAL RESERVE

LOT 11, PLAT OF CASCADE HIGHLANDS PHASE 1 & 3,

SHEET INDEX

SHEET NO.	SHEET DESCRIPTION		
1 of 2	Lot 11 Overview Plan		
2 of 2	Lot 11 Site Plan		

PLAT OF LAKE 16				
LOT 11 OVERVIEW PLAN				
RMSEN ENGINEERS SURVEYORS		6/23/23 21-414		
AIN STREET, SUITE 104 (360) 794-7811 16 (206) 343-5903 VA 98272 FAX: (360) 805-9732	1 OF 2			

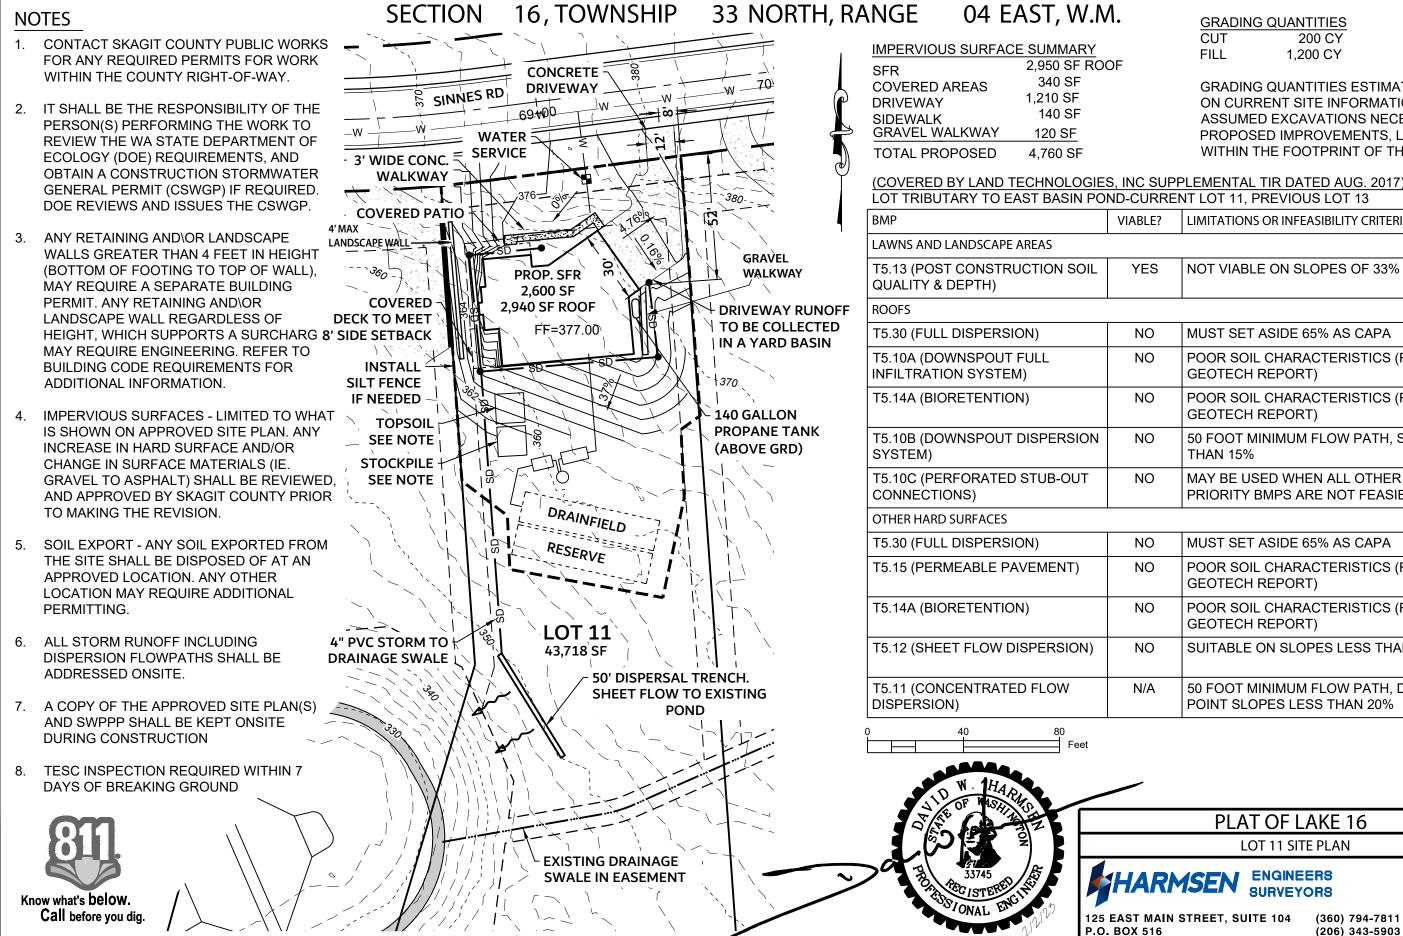

P:\WORK\PROJECTS\2021\21-414 LAKE 16\CE\SHEETS\LOT 11 SITE PLAN-REVISION.DWG 6/23/2023

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GRADING QUANTITIES CUT 200 CY FILL 1.200 CY

GRADING QUANTITIES ESTIMATED BASED ON CURRENT SITE INFORMATION & ASSUMED EXCAVATIONS NECESSARY FOR PROPOSED IMPROVEMENTS. LESS THAT WITHIN THE FOOTPRINT OF THE BLDG.

SUPPLEMENTAL TIR DATED AUG. 2017)				
JRRENT LOT 11, PREVIOUS LOT 13				
LE?	LIMITATIONS OR INFEASIBILITY CRITERIA			
ES	NOT VIABLE ON SLOPES OF 33% OR GREATER			
0	MUST SET ASIDE 65% AS CAPA			
0	POOR SOIL CHARACTERISTICS (REFER TO GEOTECH REPORT)			
0	POOR SOIL CHARACTERISTICS (REFER TO GEOTECH REPORT)			
0	50 FOOT MINIMUM FLOW PATH, SLOPES LESS THAN 15%			

MAY BE USED WHEN ALL OTHER HIGHER
PRIORITY BMPS ARE NOT FEASIBLE

0	MUST SET ASIDE 65% AS CAPA
0	POOR SOIL CHARACTERISTICS (REFER TO GEOTECH REPORT)
0	POOR SOIL CHARACTERISTICS (REFER TO GEOTECH REPORT)
0	SUITABLE ON SLOPES LESS THAN 15%
/A	50 FOOT MINIMUM FLOW PATH, DISCHARGE POINT SLOPES LESS THAN 20%

PLAT	OF LAKE 16			
LO	OT 11 SITE PLAN			
RMSEN ENGINEERS SURVEYORS			DATE: JOB #:	6/23/23
AIN STREET, SUIT	E 104 (360) 794-7811			21-414
IAN STREET, SOT 16 VA 98272	(206) 343-5903 FAX: (360) 805-9732	2 OF 2		