



TYPICAL NOTES. 7. S.G. = SAFETY GLASS

AND ELECTRICAL.

FLASHING NOTE

APPROVED CORROSION-RESISTANT FLASHING SHALL BE APPLIED SHINGLE FASHION IN SUCH A MANNER TO PREVENT ENTRY OF WATER INTO THE WALL CAVITY OR PENETRATION OF WATER INTO THE BUILDING STRUCTURAL FRAMING COMPONENTS THE FLASHING SHALL EXTEND TO THE SURFACE OF THE EXTERIOR WALL FINISH. APPROVED CORROSION

5. PROTECTION FROM DECAY IS REQUIRED FOR ALL

WOOD SIDING AND WALL FRAMING LESS THAN 2" ABOVE CONCRETE STEPS, PORCH SLABS,

RESISTANT FLASHING SHALL BE INSTALLED AT THE FOLLOWING LOCATIONS: I. EXTERIOR WINDOW AND DOOR OPENINGS. FLASHING AT EXTERIOR WINDOW AND DOOR OPENINGS SHALL EXTEND TO THE SURFACE OF THE EXTERIOR MALL FINISH OR TO THE MATER RESISTIVE BARRIER FOR SUBSEQUENT DRAINAGE

2. AT THE INTERSECTION OF CHIMNEYS OR OTHER MASONRY CONSTRUCTION WITH FRAME OR STUCCO WALLS 3. UNDER AND AT THE ENDS OF MASONRY, WOOD, OR METAL COPINGS AND SILLS


4. CONTINUOUSLY ABOVE ALL PROJECTING MOOD TRIM 5. WHERE EXTERIOR PORCHES, DECKS, OR STAIRS ATTACH TO A WALL OR FLOOR ASSEMBLY OF WOOD FRAME

6. AT WALL AND ROOF INTERSECTIONS 7. AT BUILT IN GUTTERS

3. GLAZING PER STATE ENERGY CODE. 4. SEPERATE PERMITS ARE REQUIRED FOR FENCES, PLUMBING, MECHANICAL,

EXPOSED TO THE MEATHER 6. REFER TO ALL ELEVATIONS FOR

> FRONT ELEVATION 'A SEE GENERAL NOTES SCALE: 1/4" = 1'-0"

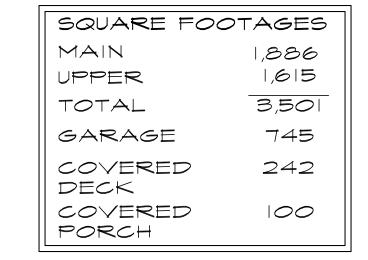

ADDRESS NOTE:


- CULTURED STONE

VENEER; INSTALL

PER MFG. SPECS

ADDRESS NUMBERS SHALL BE A MINIMUM 4" HIGH WITH A MINIMUM STROKE WIDTH OF 1/2" AND TO BE ON A CONTRASTING BACKGROUND PER IRC 319.1



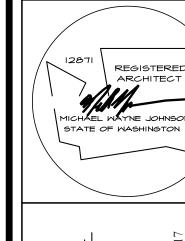


1-24-22 permit: revisions:

drawn by: LMD checked by: MMJ

SHEET



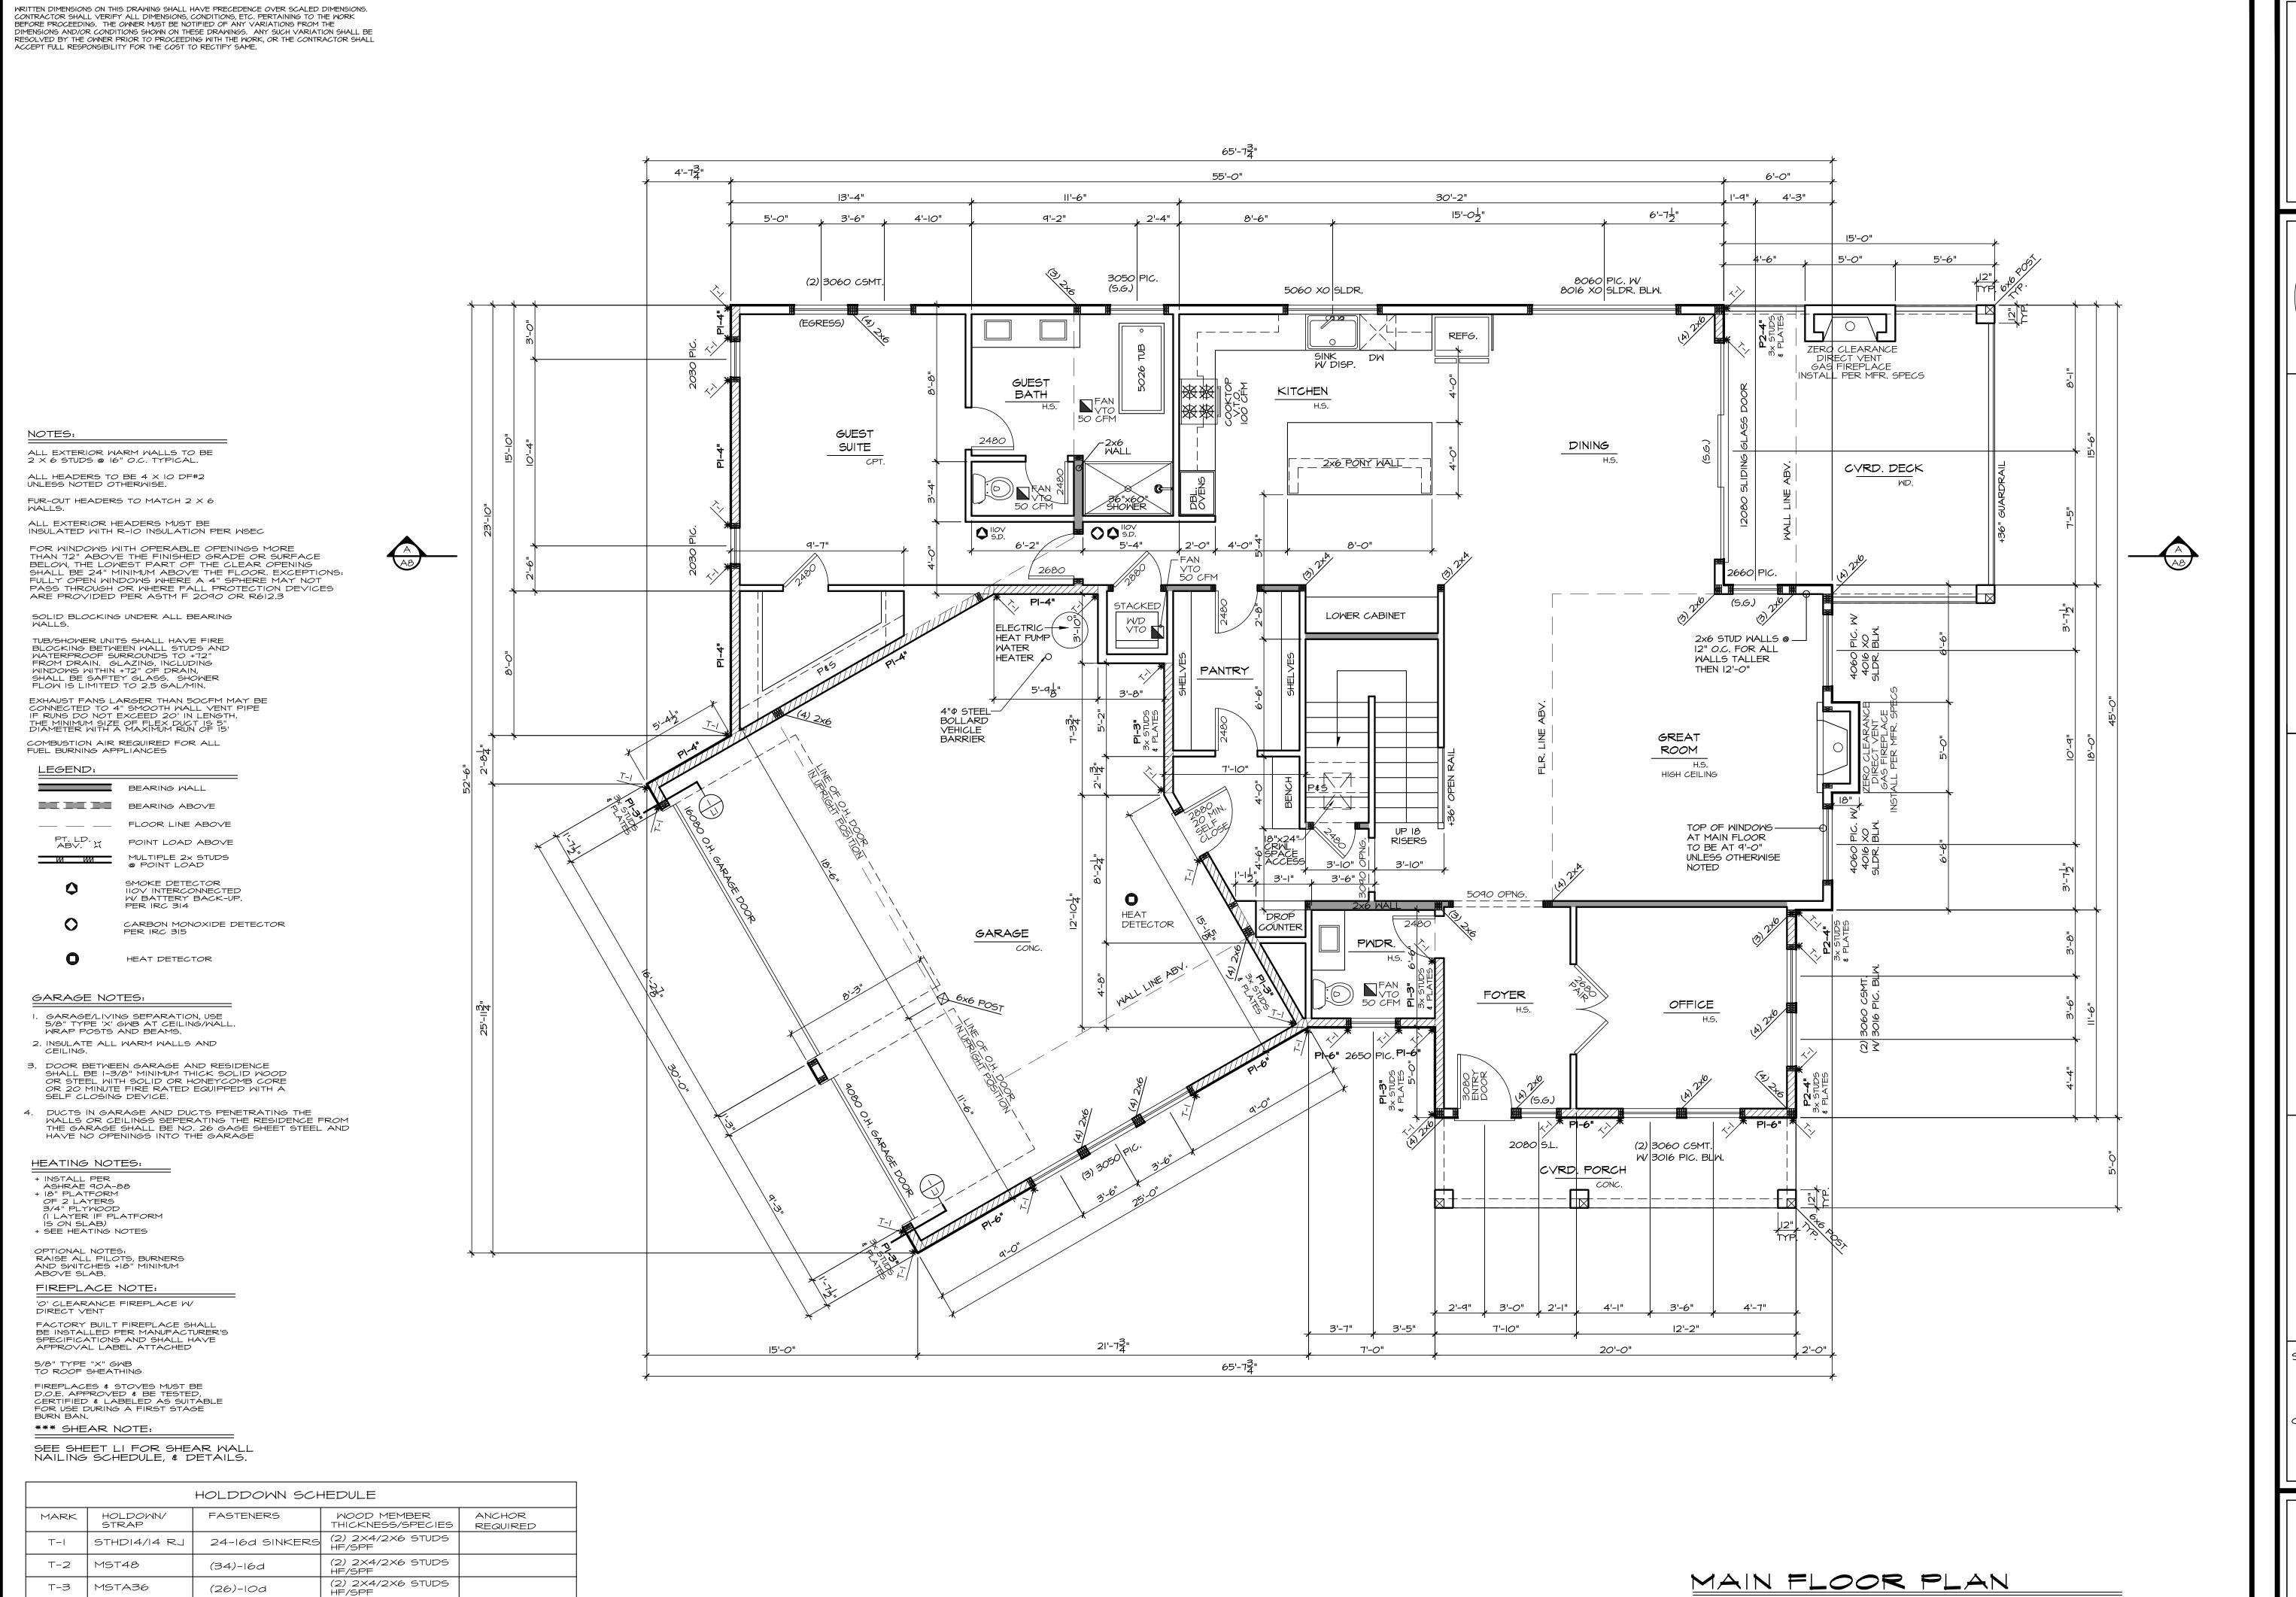

(2) 2X4/2X6 STUDS

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7/8" ANCHOR

BOLT

HF/SPF

HF/SPF

T-4

T-5

MSTC48B3

HDU8-SDS2.5

(38)-10d

× 2-1/2"

(20) SDS 1/4"

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REGISTERED

STATE OF MASHINGTON

WRITTEN DIMENSIONS ON THIS DRAWING SHALL HAVE PRECEDENCE OVER SCALED DIMENSIONS.
CONTRACTOR SHALL VERIFY ALL DIMENSIONS, CONDITIONS, ETC. PERTAINING TO THE WORK
BEFORE PROCEEDING. THE OWNER MUST BE NOTIFIED OF ANY VARIATIONS FROM THE
DIMENSIONS AND/OR CONDITIONS SHOWN ON THESE DRAWINGS. ANY SUCH VARIATION SHALL BE
RESOLVED BY THE OWNER PRIOR TO PROCEEDING WITH THE WORK, OR THE CONTRACTOR SHALL
ACCEPT FULL RESPONSIBILITY FOR THE COST TO RECTIFY SAME. 58'-8|" 16'-8<u>|</u>" 40'-0" 19'-6" 7'-10" 14'-0" <u>, 3'-0" , 2'-6" , 2'-6"</u> 3'-0" (2) 2650 PIC. 3020 PIC. 3020 PIC. (S.G.) 5026 TUB TOP OF WINDOWS —
AT UPPER FLOOR
TO BE AT 8'-O"
UNLESS OTHERWISE M.I.C. NOTED BATH PRIMARY BDRM. 2468 IIOV 🔷 S.D. 🗘 TUB/SHWR. _ _ _ _ _ _ _ _ _ _ _ _ _ _ _ _ LAUNDRY _____ P&S IIOV 🔷 S.D. 🗘 OPEN TO BDRM. #2 BELOW DN. 18 RISERS 39" TALL HALF WALL W/ WD. CAP BDRM. #3 (2) 2650 PIC. ALL EXTERIOR WARM WALLS TO BE 2 X 6 STUDS @ 16" O.C. TYPICAL. ALL HEADERS TO BE 4 X 8 DF#2 UNLESS NOTED OTHERWISE. FUR-OUT HEADERS TO MATCH 2 X 6 BONUS ALL EXTERIOR HEADERS MUST BE INSULATED WITH R-10 INSULATION PER WSEC FOR WINDOWS WITH OPERABLE OPENINGS MORE
THAN 72" ABOVE THE FINISHED GRADE OR SURFACE
BELOW, THE LOWEST PART OF THE CLEAR OPENING
SHALL BE 24" MINIMUM ABOVE THE FLOOR. EXCEPTIONS:
FULLY OPEN WINDOWS WHERE A 4" SPHERE MAY NOT PASS THROUGH OR WHERE FALL PROTECTION DEVICES ARE PROVIDED PER ASTM F 2090 OR R612.3 SOLID BLOCKING UNDER ALL BEARING WALLS. TUB/SHOWER UNITS SHALL HAVE FIRE BLOCKING BETWEEN WALL STUDS AND WATERPROOF SURROUNDS TO +72" FROM DRAIN. GLAZING, INCLUDING WINDOWS WITHIN +72" OF DRAIN, SHALL BE SAFTEY GLASS. SHOWER FLOW IS LIMITED TO 2.5 GAL/MIN. 9050 XOX SLDR. EXHAUST FANS LARGER THAN 50CFM MAY BE CONNECTED TO 4" SMOOTH WALL VENT PIPE IF RUNS DO NOT EXCEED 20' IN LENGTH. THE MINIMUM SIZE OF FLEX DUCT IS 5" DIAMETER WITH A MAXIMUM RUN OF IS' COMBUSTION AIR REQUIRED FOR ALL FUEL BURNING APPLIANCES BEARING WALL BEARING ABOVE ___ FLOOR LINE ABOVE POINT LOAD ABOVE MULTIPLE 2x STUDS

POINT LOAD 2'-6" 3'-0" 2'-3" SMOKE DETECTOR IIOV INTERCONNECTED W/ BATTERY BACK-UP. PER IRC 314 12'-0" 17'-0" 58'-8|" CARBON MONOXIDE DETECTOR PER IRC 315 *** SHEAR NOTE: SEE SHEET LI FOR SHEAR WALL NAILING SCHEDULE, & DETAILS. HOLDDOWN SCHEDULE MOOD MEMBER THICKNESS/SPECIES HOLDOWN/ STRAP FASTENERS ANCHOR MARK 24-16d SINKERS (2) 2X4/2X6 STUDS HF/SPF T-ISTHDI4/I4 RJ (2) 2X4/2X6 STUDS HF/SPF T-2 MST48 (34)-16d (2) 2X4/2X6 STUDS HF/SPF T-3 MSTA36 (26)-10d (2) 2X4/2X6 STUDS HF/SPF UPPER FLOOR PLAN T-4 MSTC48B3 (38)-10d (2) 2X4/2X6 STUDS 7/8" ANCHOR HF/SPF BOLT T-5 HDU8-SDS2.5 (20) SDS 1/4"

× 2-1/2"

date: 1-24-22 permit: revisions: drawn by: LMD checked by: MMJ SHEET SCALE: 1/4" = 1'-0" SEE GENERAL NOTES

REGISTERE

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