

NOTES

- I. ALL WOOD EXPOSED TO WEATHER SHALL BE PRESSURE TREATED, PAINTED OR CEDAR.
- 2. CAULK AND SEAL ALL WINDOW/DOOR AND EXTERIOR ENVELOPE PENETRATIONS.
- 3. GLAZING PER STATE ENERGY CODE.
- 4. SEPERATE PERMITS ARE REQUIRED FOR FENCES, PLUMBING, MECHANICAL, AND ELECTRICAL.
- 5. PROTECTION FROM DECAY IS REQUIRED FOR ALL WOOD SIDING AND WALL FRAMING LESS THAN 2" ABOVE CONCRETE STEPS, PORCH SLABS, PATIO SLABS, AND SIMILAR HORIZONTAL SURFACES EXPOSED TO THE WEATHER

APPROVED CORROSION-RESISTANT FLASHING

- 6. REFER TO ALL ELEVATIONS FOR TYPICAL NOTES.
- 7. S.G. = SAFETY GLASS

FLASHING NOTE

SHALL BE APPLIED SHINGLE FASHION IN SUCH A
MANNER TO PREVENT ENTRY OF WATER INTO THE
WALL CAVITY OR PENETRATION OF WATER INTO
THE BUILDING STRUCTURAL FRAMING COMPONENTS
THE FLASHING SHALL EXTEND TO THE SURFACE OF
THE EXTERIOR WALL FINISH. APPROVED CORROSION
RESISTANT FLASHING SHALL BE INSTALLED AT THE FOLLOWING LOCATIONS:

I. EXTERIOR WINDOW AND DOOR OPENINGS. FLASHING AT EXTERIOR WINDOW

AND DOOR OPENINGS GUALL EXTERIOR TO THE SURFACE OF THE EXTERIOR WINDOW

I. EXTERIOR WINDOW AND DOOR OPENINGS. FLASHING AT EXTERIOR WINDOW AND DOOR OPENINGS SHALL EXTEND TO THE SURFACE OF THE EXTERIOR WALL FINISH OR TO THE WATER RESISTIVE BARRIER FOR SUBSEQUENT

2. AT THE INTERSECTION OF CHIMNEYS OR OTHER MASONRY CONSTRUCTION WITH FRAME OR STUCCO WALLS
3. UNDER AND AT THE ENDS OF MASONRY, WOOD, OR METAL COPINGS AND SILLS

4. CONTINUOUSLY ABOVE ALL PROJECTING WOOD TRIM
5. WHERE EXTERIOR PORCHES, DECKS, OR STAIRS ATTACH
TO A WALL OR FLOOR ASSEMBLY OF WOOD FRAME
CONSTRUCTION

6. AT WALL AND ROOF INTERSECTIONS
7. AT BUILT IN GUTTERS



SQUARE FOOTAGES

MAIN
UPPER
1,630

TOTAL
3,460

GARAGE
693

COVERED
252
DECK
FRONT CYRD. 140
PORCH

SIDE CYRD. 54
PORCH

ADDRESS NOTE:

ADDRESS NUMBERS SHALL BE
A MINIMUM 4" HIGH WITH A
MINIMUM STROKE WIDTH OF 1/2"
AND TO BE ON A CONTRASTING
BACKGROUND PER IRC 319.1



A R C H I T E C T S


8003 118th AVENUE NE. KIRKLAND, WA. 98033. 425-828-41

LAKE SIXTEEN PLAN 9460 FLEYATION A


0' 0 date: 1-24-22 permit:

revisions:

drawn by: LMD checked by: MMJ

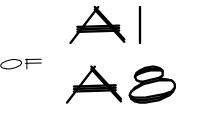



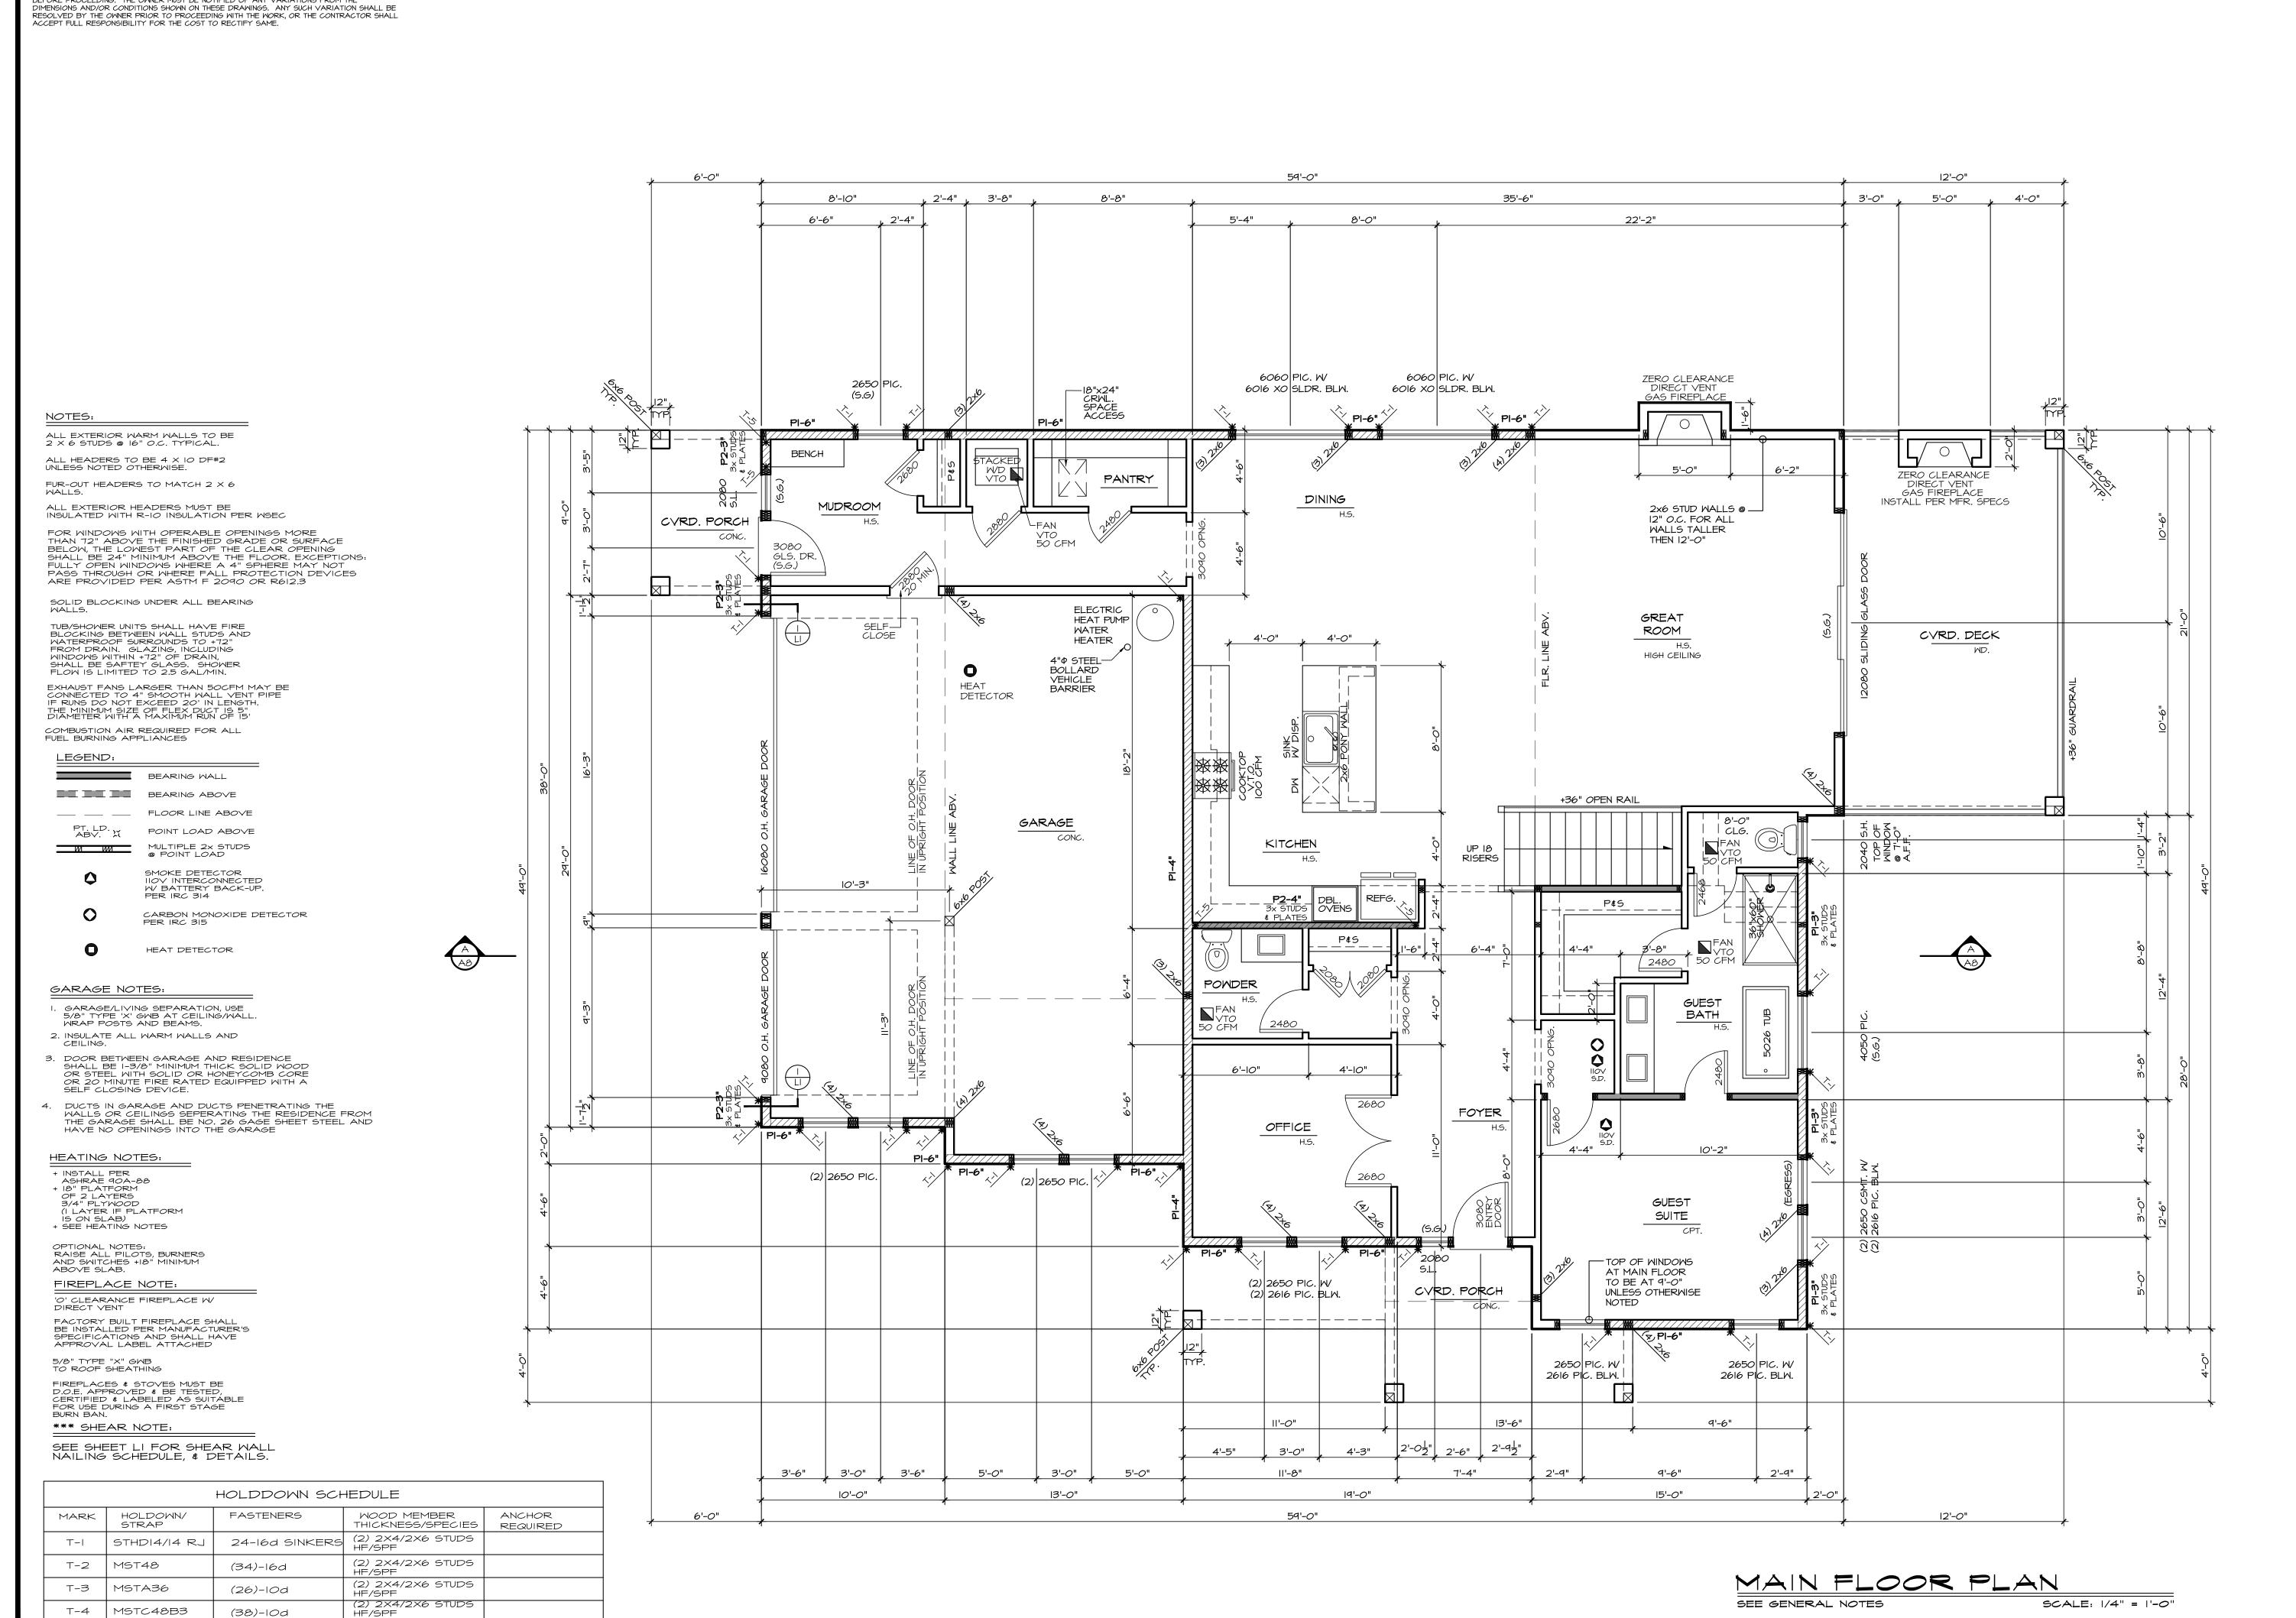

WRITTEN DIMENSIONS ON THIS DRAWING SHALL HAVE PRECEDENCE OVER SCALED DIMENSIONS. CONTRACTOR SHALL VERIFY ALL DIMENSIONS, CONDITIONS, ETC. PERTAINING TO THE WORK BEFORE PROCEEDING. THE OWNER MUST BE NOTIFIED OF ANY VARIATIONS FROM THE

7/8" ANCHOR

BOLT

(2) 2X4/2X6 STUDS

HF/SPF

T-5

HDU8-SDS2.5

(20) SDS 1/4"

× 2-1/2"

REGISTERED STATE OF WASHINGTON 1-24-22 date: permit: revisions: LMD drawn by: checked by: MMJ SHEET

WRITTEN DIMENSIONS ON THIS DRAWING SHALL HAVE PRECEDENCE OVER SCALED DIMENSIONS.
CONTRACTOR SHALL VERIFY ALL DIMENSIONS, CONDITIONS, ETC. PERTAINING TO THE WORK
BEFORE PROCEEDING. THE OWNER MUST BE NOTIFIED OF ANY VARIATIONS FROM THE
DIMENSIONS AND/OR CONDITIONS SHOWN ON THESE DRAWINGS. ANY SUCH VARIATION SHALL BE
RESOLVED BY THE OWNER PRIOR TO PROCEEDING WITH THE WORK, OR THE CONTRACTOR SHALL
ACCEPT FULL RESPONSIBILITY FOR THE COST TO RECTIFY SAME.

ALL EXTERIOR WARM WALLS TO BE 2 X 6 STUDS @ 16" O.C. TYPICAL.

FUR-OUT HEADERS TO MATCH 2 X 6

SOLID BLOCKING UNDER ALL BEARING WALLS.

TUB/SHOWER UNITS SHALL HAVE FIRE BLOCKING BETWEEN WALL STUDS AND WATERPROOF SURROUNDS TO +72" FROM DRAIN. GLAZING, INCLUDING WINDOWS WITHIN +72" OF DRAIN, SHALL BE SAFTEY GLASS. SHOWER FLOW IS LIMITED TO 2.5 GAL/MIN.

THE MINIMUM SIZE OF FLEX DUCT IS 5" DIAMETER WITH A MAXIMUM RUN OF IS'

COMBUSTION AIR REQUIRED FOR ALL FUEL BURNING APPLIANCES

BEARING WALL

BEARING ABOVE

MULTIPLE 2x STUDS

POINT LOAD

SEE SHEET LI FOR SHEAR WALL NAILING SCHEDULE, & DETAILS.

HOLDOWN/ STRAP

MSTC48B3

MST48

T-5 HDU8-SDS2.5

T-3 MSTA36

STHDI4/I4 RJ

*** SHEAR NOTE:

MARK

T-2

T-4

EXHAUST FANS LARGER THAN 50CFM MAY BE

FLOOR LINE ABOVE

POINT LOAD ABOVE

SMOKE DETECTOR IIOV INTERCONNECTED W/ BATTERY BACK-UP. PER IRC 314

CARBON MONOXIDE DETECTOR PER IRC 315

FASTENERS

(34)-16d

(26)-10d

(38)-10d

× 2-1/2"

(20) SDS 1/4"

(2) 2X4/2X6 STUDS HF/SPF

(2) 2X4/2X6 STUDS HF/SPF

(2) 2X4/2X6 STUDS 7/8" ANCHOR


CONNECTED TO 4" SMOOTH WALL VENT PIPE IF RUNS DO NOT EXCEED 20' IN LENGTH.

ALL EXTERIOR HEADERS MUST BE INSULATED WITH R-10 INSULATION PER WSEC

FOR WINDOWS WITH OPERABLE OPENINGS MORE
THAN 72" ABOVE THE FINISHED GRADE OR SURFACE
BELOW, THE LOWEST PART OF THE CLEAR OPENING
SHALL BE 24" MINIMUM ABOVE THE FLOOR. EXCEPTIONS:
FULLY OPEN WINDOWS WHERE A 4" SPHERE MAY NOT

PASS THROUGH OR WHERE FALL PROTECTION DEVICES ARE PROVIDED PER ASTM F 2090 OR R612.3

ALL HEADERS TO BE 4 X 8 DF#2 UNLESS NOTED OTHERWISE.

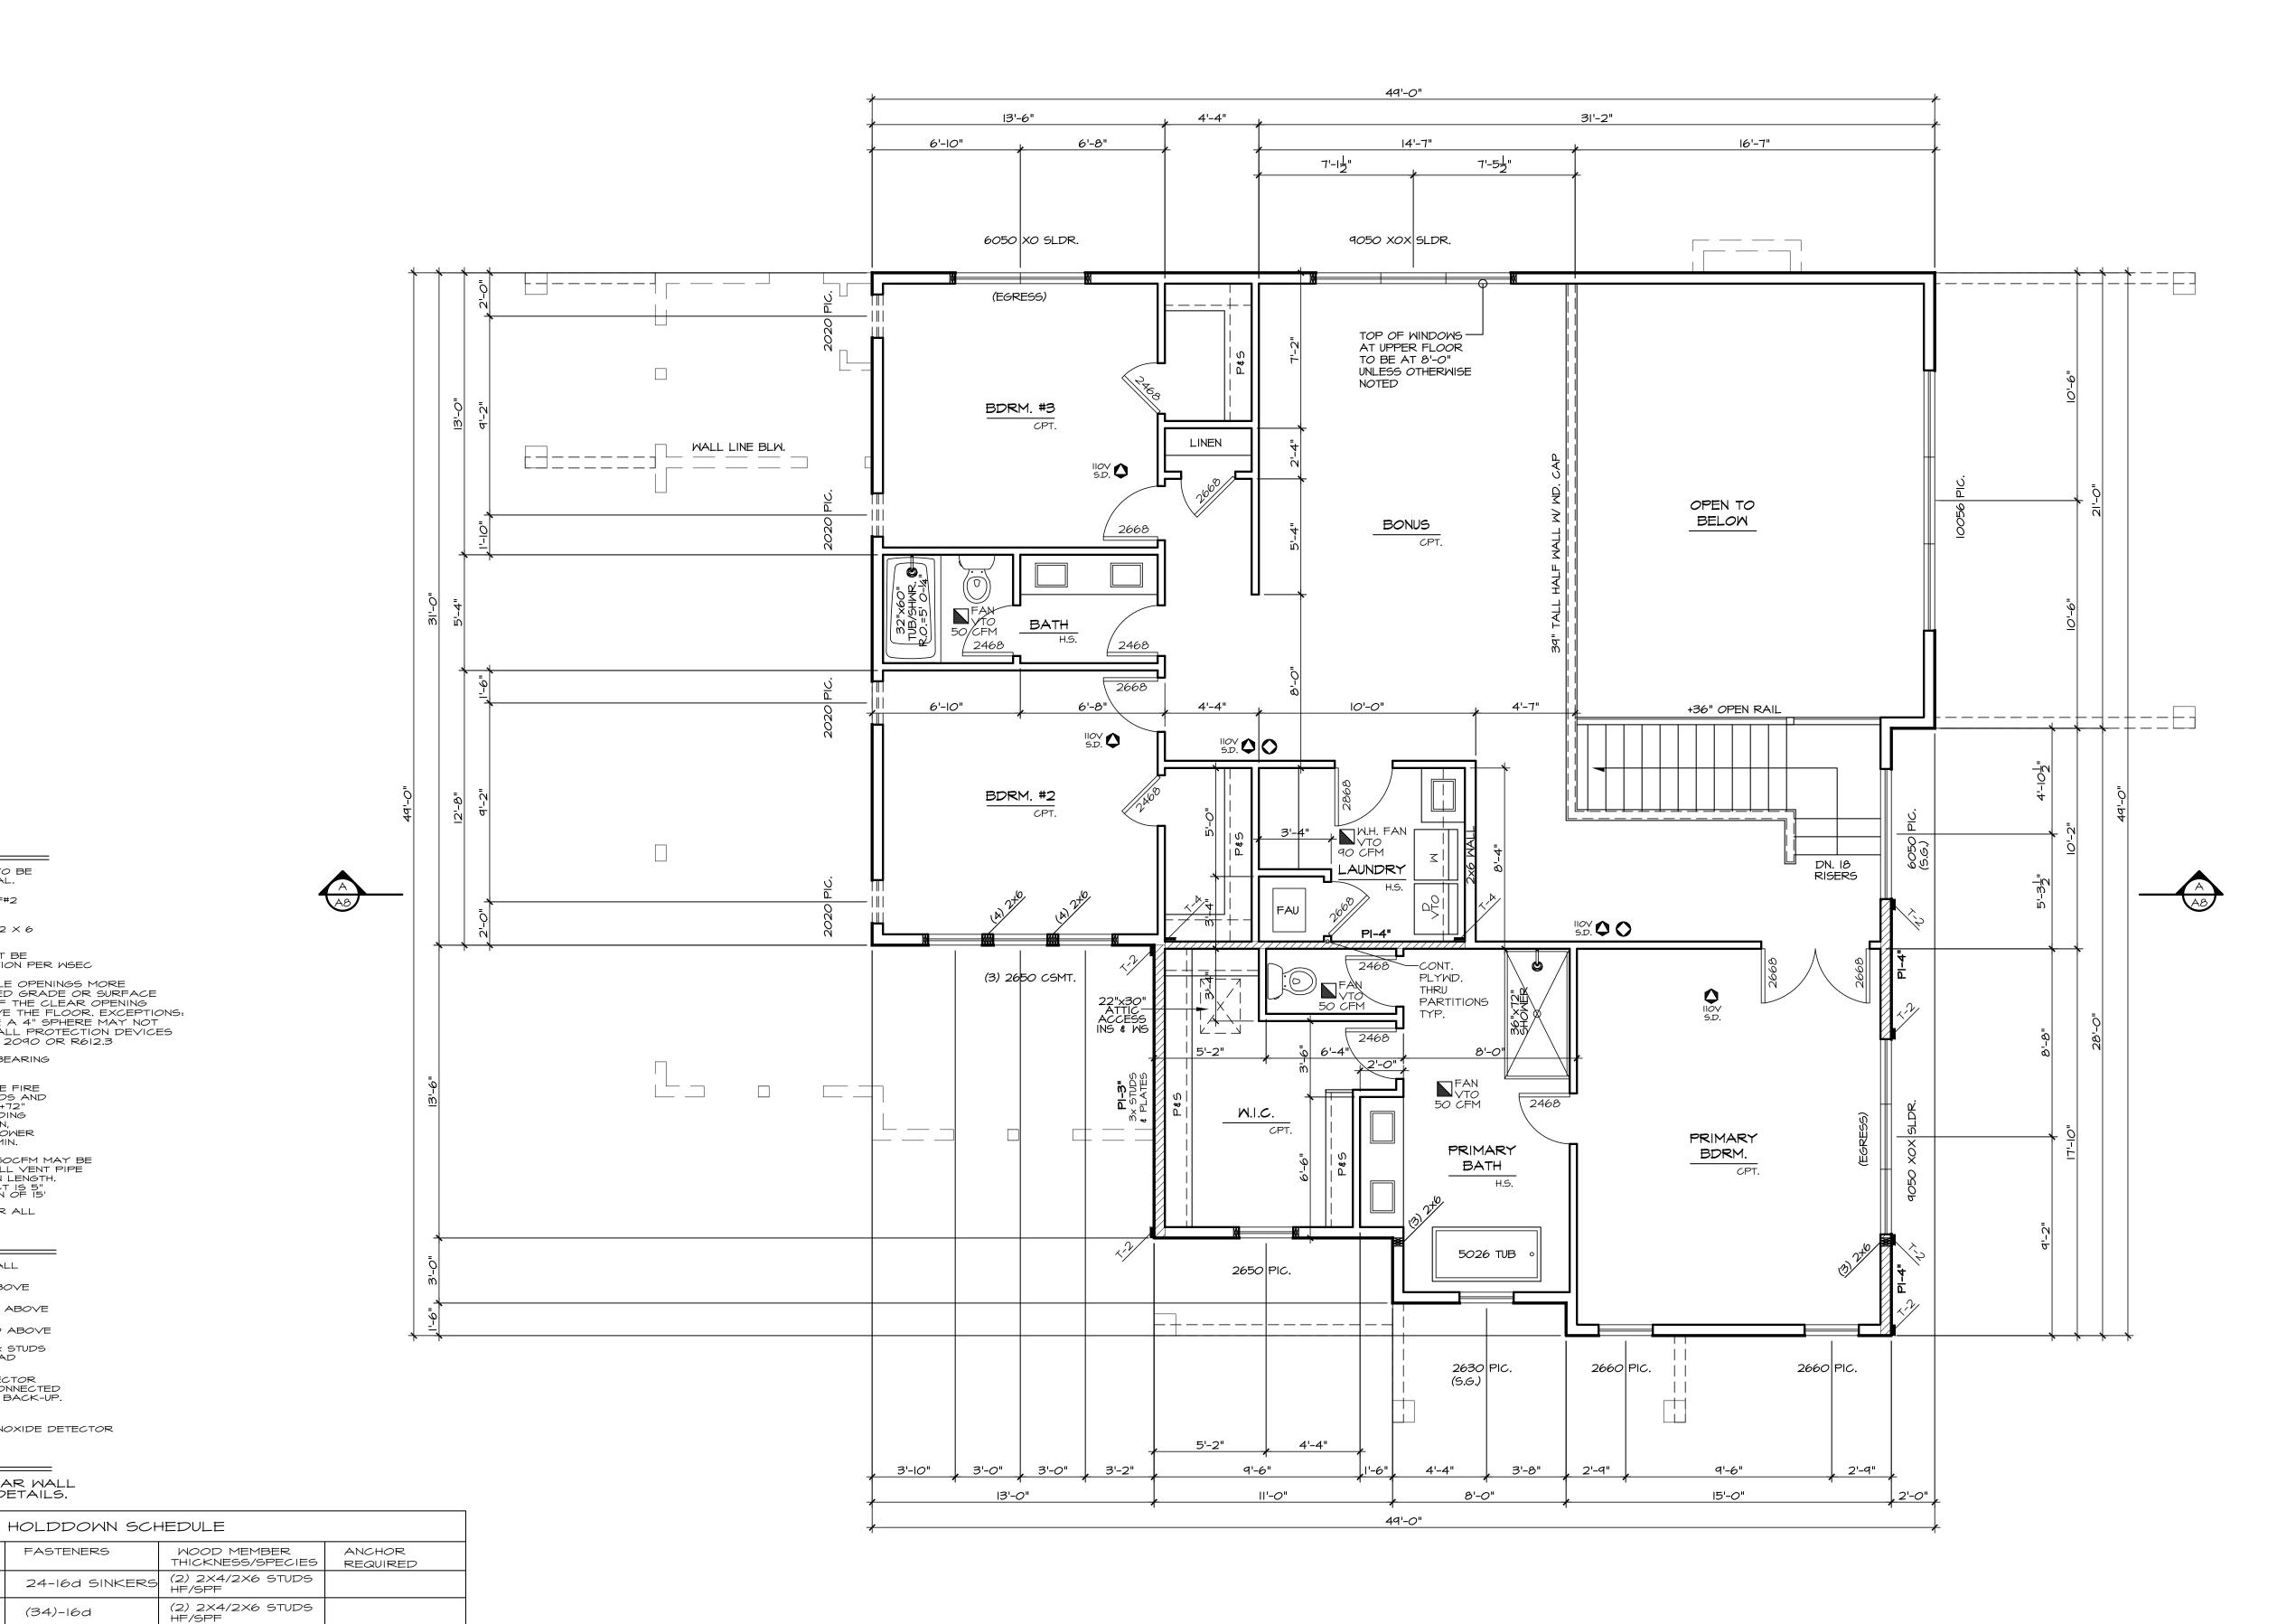

UPPER FLOOR PLAN

SEE GENERAL NOTES

SCALE: 1/4" = 1'-0"



SH

date: 1-24-22 permit:

revisions:

drawn by: LMD checked by: MMJ

SHEET